



ABBREVIATIONS

A.F.F	ABOVE FINISH FLOOR	N.I.C.	NOT IN CONTRACT
ACT.	ACOUSTICAL TILE	NOM.	NOMINAL NUMBER
A.C.	AIR CONDITION	O.C.	ON CENTER
ALUM.	ALUMINUM	OPNG	OPENING
APPROX.	APPROXIMATE	OPPOSITE	OPPOSITE HAND
ARCH.	ARCHITECTURAL	OH	OVERHEAD
AUTO	AUTOMATIC	PMBC	PREENGINEERED METAL BUILDING CONTRACTOR
BM	BEAM	PNT	PANEL
BRG	BEARING	P.N.D.	PAPER TOWEL DISPENSER
B.M.	BENCH MARK	P.T.R.	PAPER TOWEL RECEPTOR
BLK	BLOCK	P.V.M.T.	PAVEMENT
BLDG	BUILDING	PC	PER BOARD
BO	BOTTOM	PLAS	PLASTER
BRK	BRICK	P.LAM	PLATE LAMINATE
B.R.K.	BRICK EXPANSION JOINT	POL	POLISHED
B.C.	BRICK COURSE	P.P.	PLYWOOD
B.L.G.	BUILT-UP ROOFING	PT	POINT
BUR	BUR	P.S.F.	POUNDS PER SQ. INCH
CLG.	CEILING	P.S.F.	POUNDS PER SQ. FOOT
CBS	CABINET	PRE. FAB.	PREFABRICATED
CPT	CARPENTRY	PREF.	PREFINISHED
C.W.	CATCH BASIN	PROJ.	PROJECTION
C.B.	CERAMIC TILE	PL	PROPERTY LINE
C.M.	CEMENT	QT	QUARRY TILE
CHBD	CHALK BOARD	RAD	RADIUS
CL	CLEAR	R.W.L.	RAIN WATER LEADER
COL.	COLUMN	REC.	RECESS
CONC.	CONCRETE	REFR.	REFRIGERATOR
CMU	CONCRETE MASONRY UNIT	REG.	REGISTER
CONTR.	CONTRACTOR	REIN.	REINFORCE (D) (ING)
CONT.	CONTINUOUS	REIN.	REINFORCE (D)
C.C.	CORNER GUARD	RES.	RECESS (ED)
C.S.	COUNTER SINK	R.C.P.	RECESSED CEILING PLAN
C.R.	CURTAIN ROD	RET.	RETURN
DET.	DETAIL	R.V.S.	RETURN AIR
DIA.	DIAMETER	REV.	REVISION
DIM.	DIMENSION	R.H.W.	RIGHT HAND
DISP.	DISPENSER	R.W.	RIGHT OF WAY
DN	DOWN	R.D.	ROOF DRAIN
DWG.	DRAWING	RFG	ROOFING
D.F.	DRINKING FOUNTAIN	RND	ROUND
DIFF.	DIFFUSER	SDL	SADDLE
EA	EACH	SECT	SECTION
E.I.S.	EXTERIOR INSULATION & FINISH SYSTEM	SECT.	SECTION
ELEC.	ELECTRICAL	SH	SHEDDING SHEET
EPNL	ELECTRICAL PANEL	SHR	SHOWER
ELEV.	ELEVATOR	SM	SINK
EXP.	EXPANSION JOINT	SPKR	SPEAKER
EXP. JT.	EXPANSION JOINT	SPEC	SPECIFICATIONS
F.A.C.	FACE BRICK	SQ.	SQUARE
F.N.D.	FEMININE NAPKIN DISPOSAL	SSST	STAINLESS STEEL
F.N.V.	FEMININE NAPKIN VENDOR	STD	STANDARD
FIN.	FINISH (ED)	STD	STANDARD
F.A.	FIRE ALARM	STD	STANDARD
F.E.	FIRE EXTINGUISHER	STD	STANDARD
F.H.C.	FIRE HOSE CABINET	STD	STANDARD
F.H.	FIRE HOSE	STD	STANDARD
F.P.	FIRE PROOFING	STD	STANDARD
FL.	FLOOR	STD	STANDARD
F.D.	FLOOR DRAIN	STD	STANDARD
F.O.	FACE WALL COVERING	STD	STANDARD
F.F.	FACE WALL COVERING	STD	STANDARD
F.T.	FOOTING	STD	STANDARD
FDN	FOUNDATION	STD	STANDARD
FUR	FURRING	STD	STANDARD
GAL	GALLON	S.G.T.	STRUCTURAL GLAZED TILE
G.C.	GENERAL CONTRACTOR	STRUC.	STRUCTURAL
G.B.	GYP. BAR	SUSP.	SUSPENDED
G.W.B.	GYP. WALL BOARD	SW	SWITCH
GYP.	GYP. WALL BOARD	SWBD	SWITCH BOARD
HDW.	HARDWARE	SVS	SYMMETRICAL SHEET VINYL
H.W.	HARDWOOD	T.B.	TACKBOARD
H.V.A.C.	HEATING, VENTILATING, & AIR CONDITIONING	TEL	TELEPHONE
HT	HEIGHT	TEMP	TEMPERATURE
HC	HOLLOW CORE	TEX	TEXTURE
H.M.	HOLLOW METAL	THK	THICK (NESS)
HORIZ	HORIZONTAL	THR	THRESHOLD
H.B.	HOSE BIB	T.D.	TISSUE DISPENSER
H.W.	HOT WATER	TP	TOILET PAPER HOLDER
INSUL.	INSULATE (D) (ING)	TOS	TOP OF WALL
INS. GL	INSULATED GLASS	TOW	TOWEL BAR
INV	INVERT	TYP	TYPICAL
JAN	JANITOR	U.C.L.	UNDER CABINET LIGHT
JT	JOINT	UR	URINAL
KIT	KITCHEN	V.T.R.	VENT THRU ROOF
KO	KNOCK OUT	VENT	VENTILATOR
LAM	LAMINATED	VERT	VERTICAL
LH	LEFT HAND	VEST	VESTIBULE
LGT	LIGHT	V.C.T.	VARIABLE COMPOSITE TILE
L	LENGTH	V.I.F.	VERIFY IN FIELD
L.F.	LINEAR FEET	V.W.C.	VINYL WALL COVERING
LL	LIVE LOAD	WSCT	WAINSCOT
LLV	LONG LEG HORIZONTAL	WS	WEATHER STRIP
LLV	LONG LEG VERTICAL	WF	WEIGHT
L.M.F.	LIGHT GAUGE METAL FRAMING	WWF	WELDED WIRE FABRIC
L.P.	LOW POINT	W.C.D.F.	WHEELCHAIR DRINKING FOUNTAIN
MACH	MACHINE	W/O	WITHOUT
M.H.	MANHOLE	W/O	WITHOUT
MFR	MANUFACTURE	W/O	WITHOUT
MAS	MASONRY	W/O	WITHOUT
M.O.	MASONRY OPENING	W/O	WITHOUT
MAX	MAXIMUM	W/O	WITHOUT
MATL	MATERIAL	W/O	WITHOUT
MECH	MECHANICAL	W/O	WITHOUT
MEMB	MEMBRANE	W/O	WITHOUT
MET	METAL	W/O	WITHOUT
M.T.P.	METAL TOILET PARTITION	W/O	WITHOUT
MIN.	MINIMUM	W/O	WITHOUT
MISC.	MISCELLANEOUS	W/O	WITHOUT
MULL	MULLION	W/O	WITHOUT

DRAFTING SYMBOLS

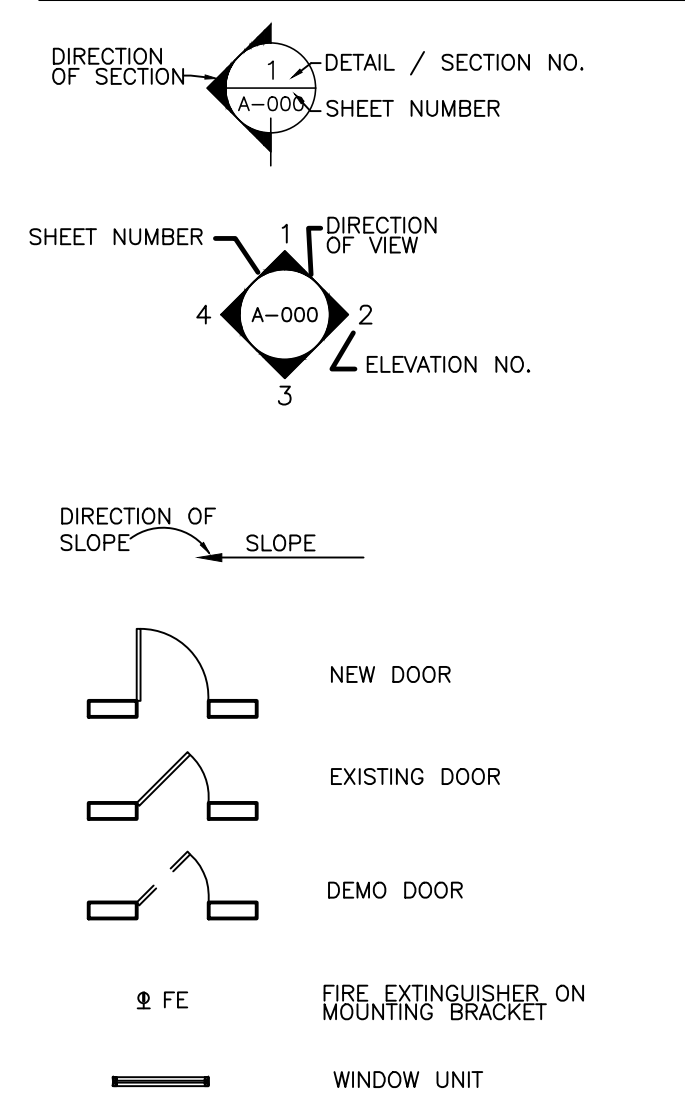


MATERIAL SYMBOLS


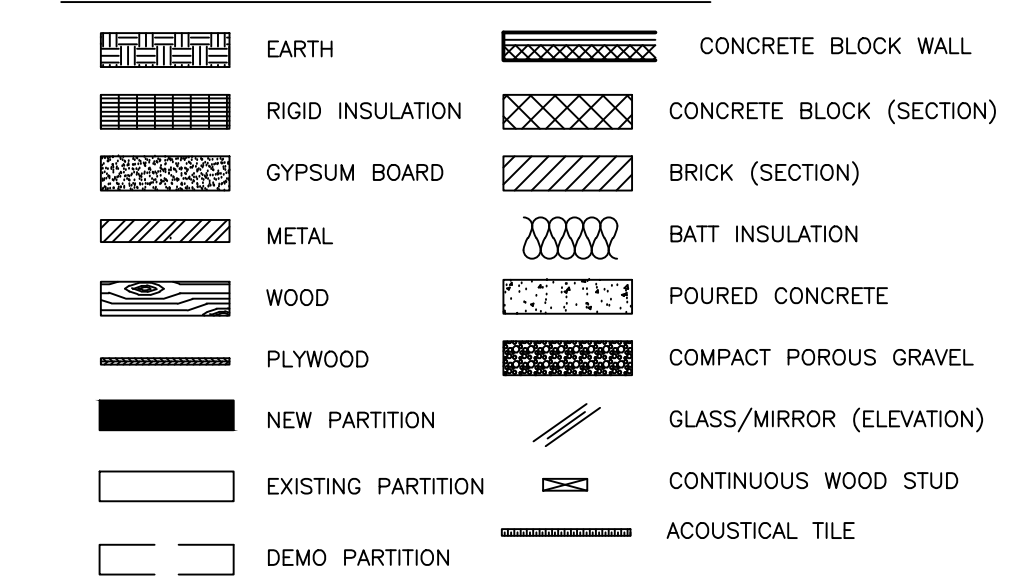


BUILDING DATA

OCCUPANCY CLASSIFICATION: S-2
CONSTRUCTION TYPE: III-B
MASONRY BUILDING

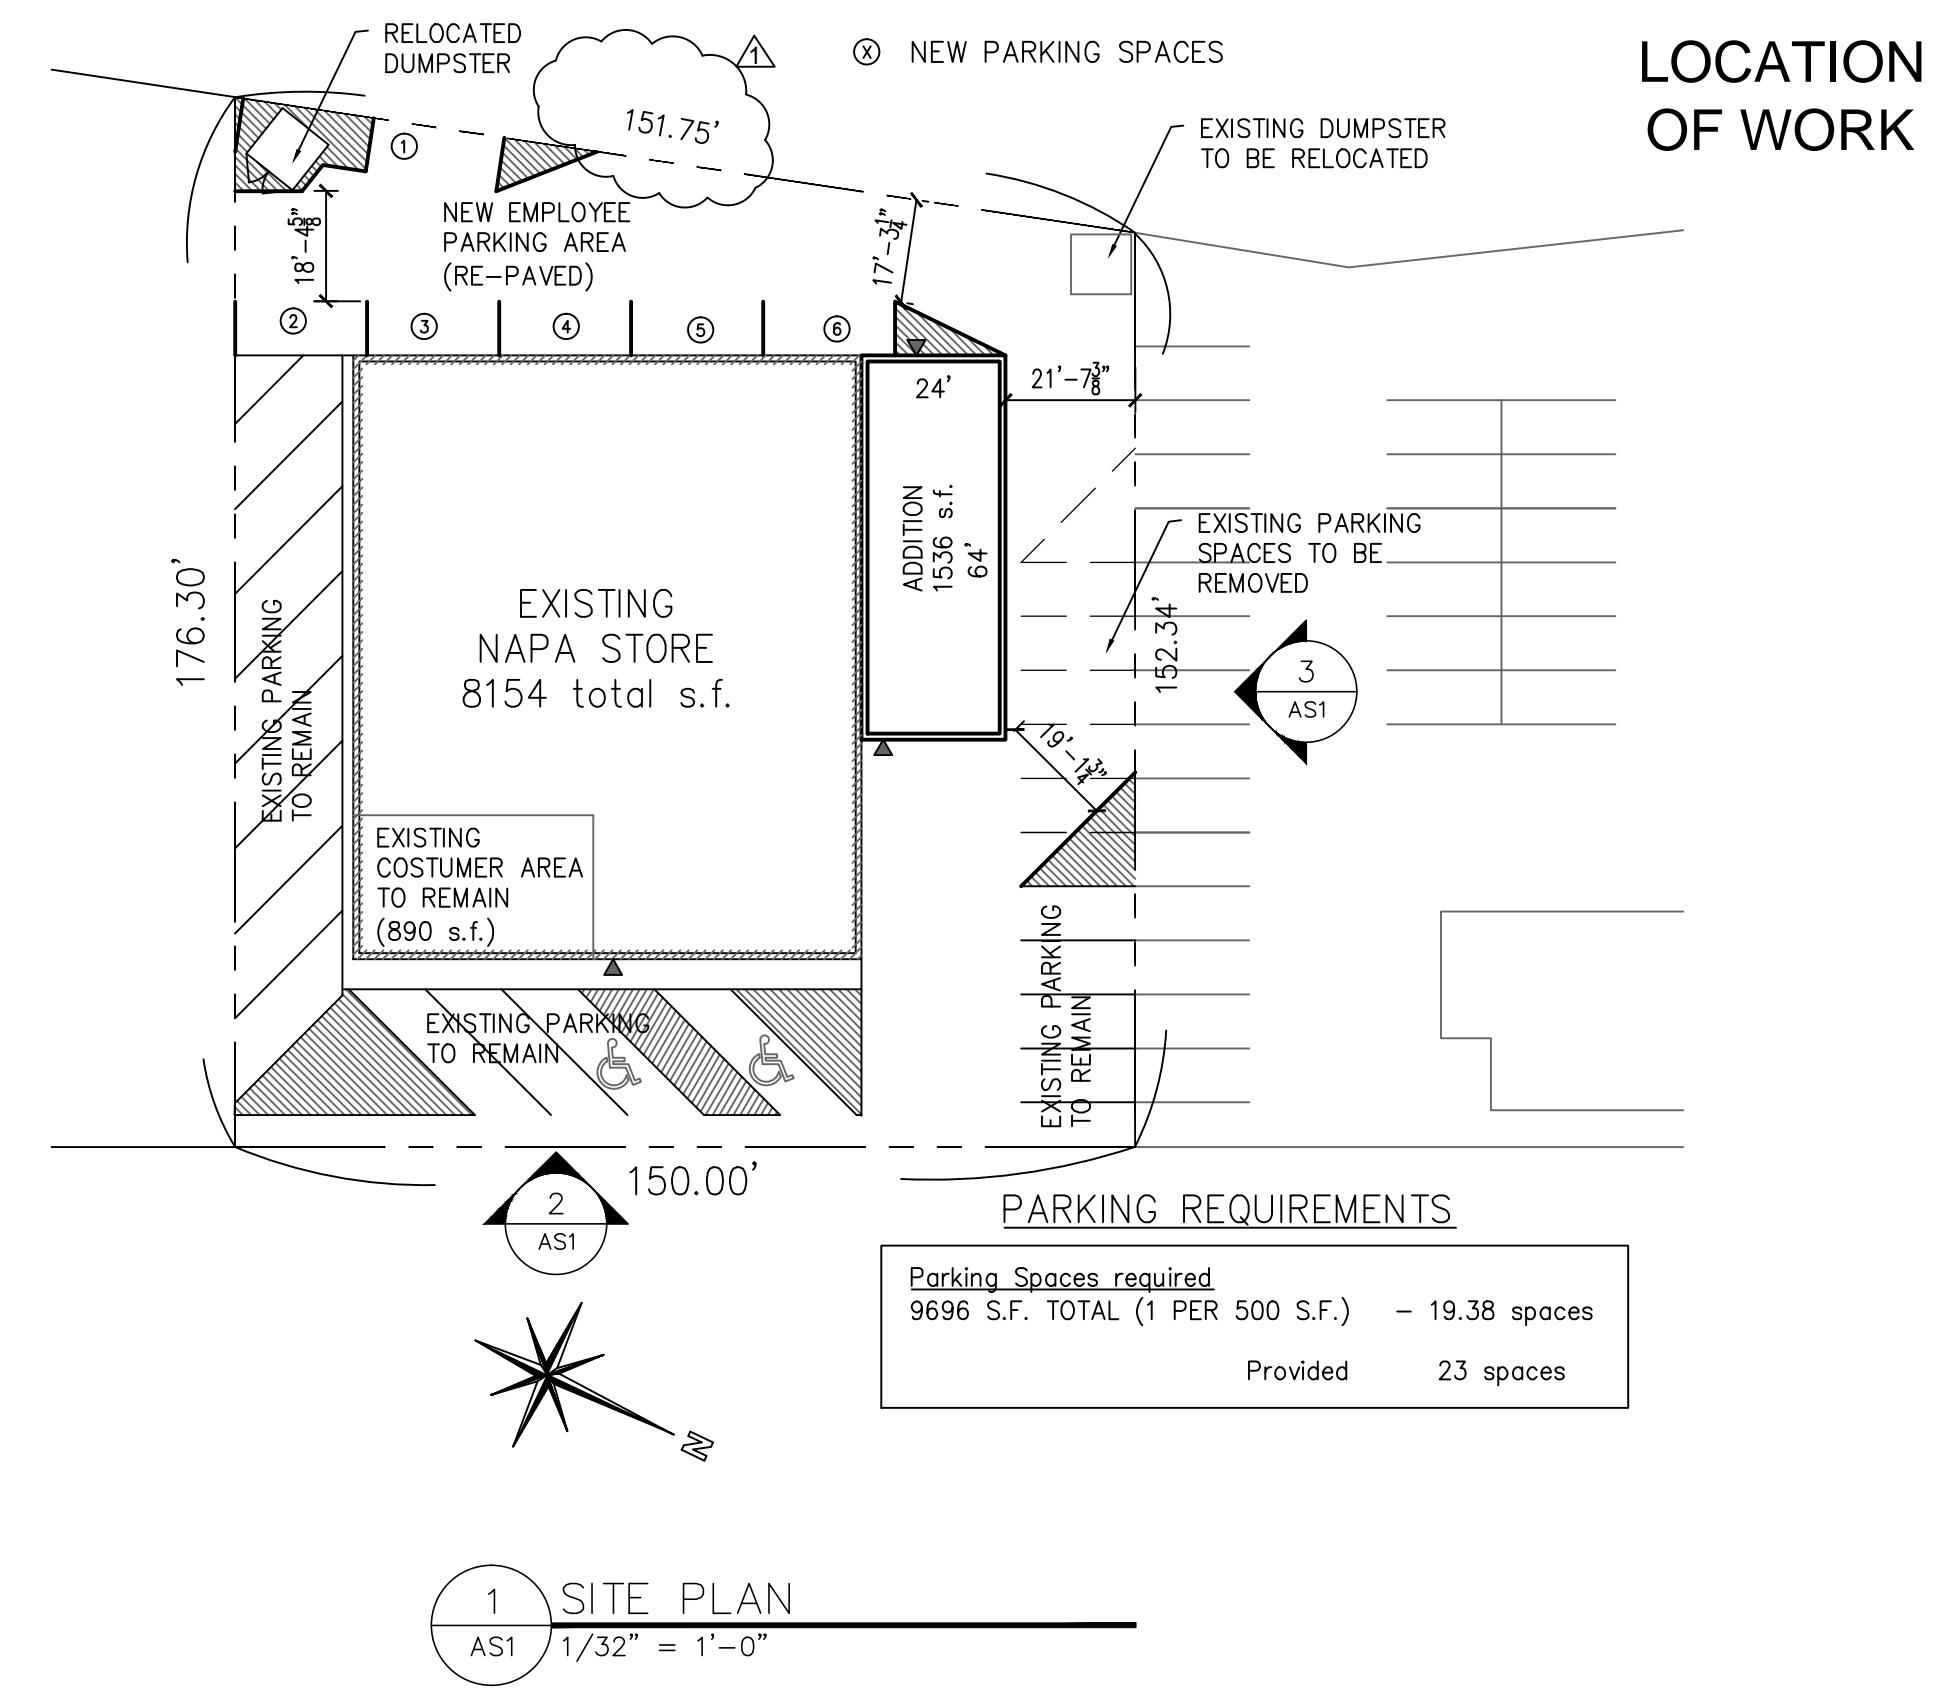

SITE LOCATION
SCALE: NTS

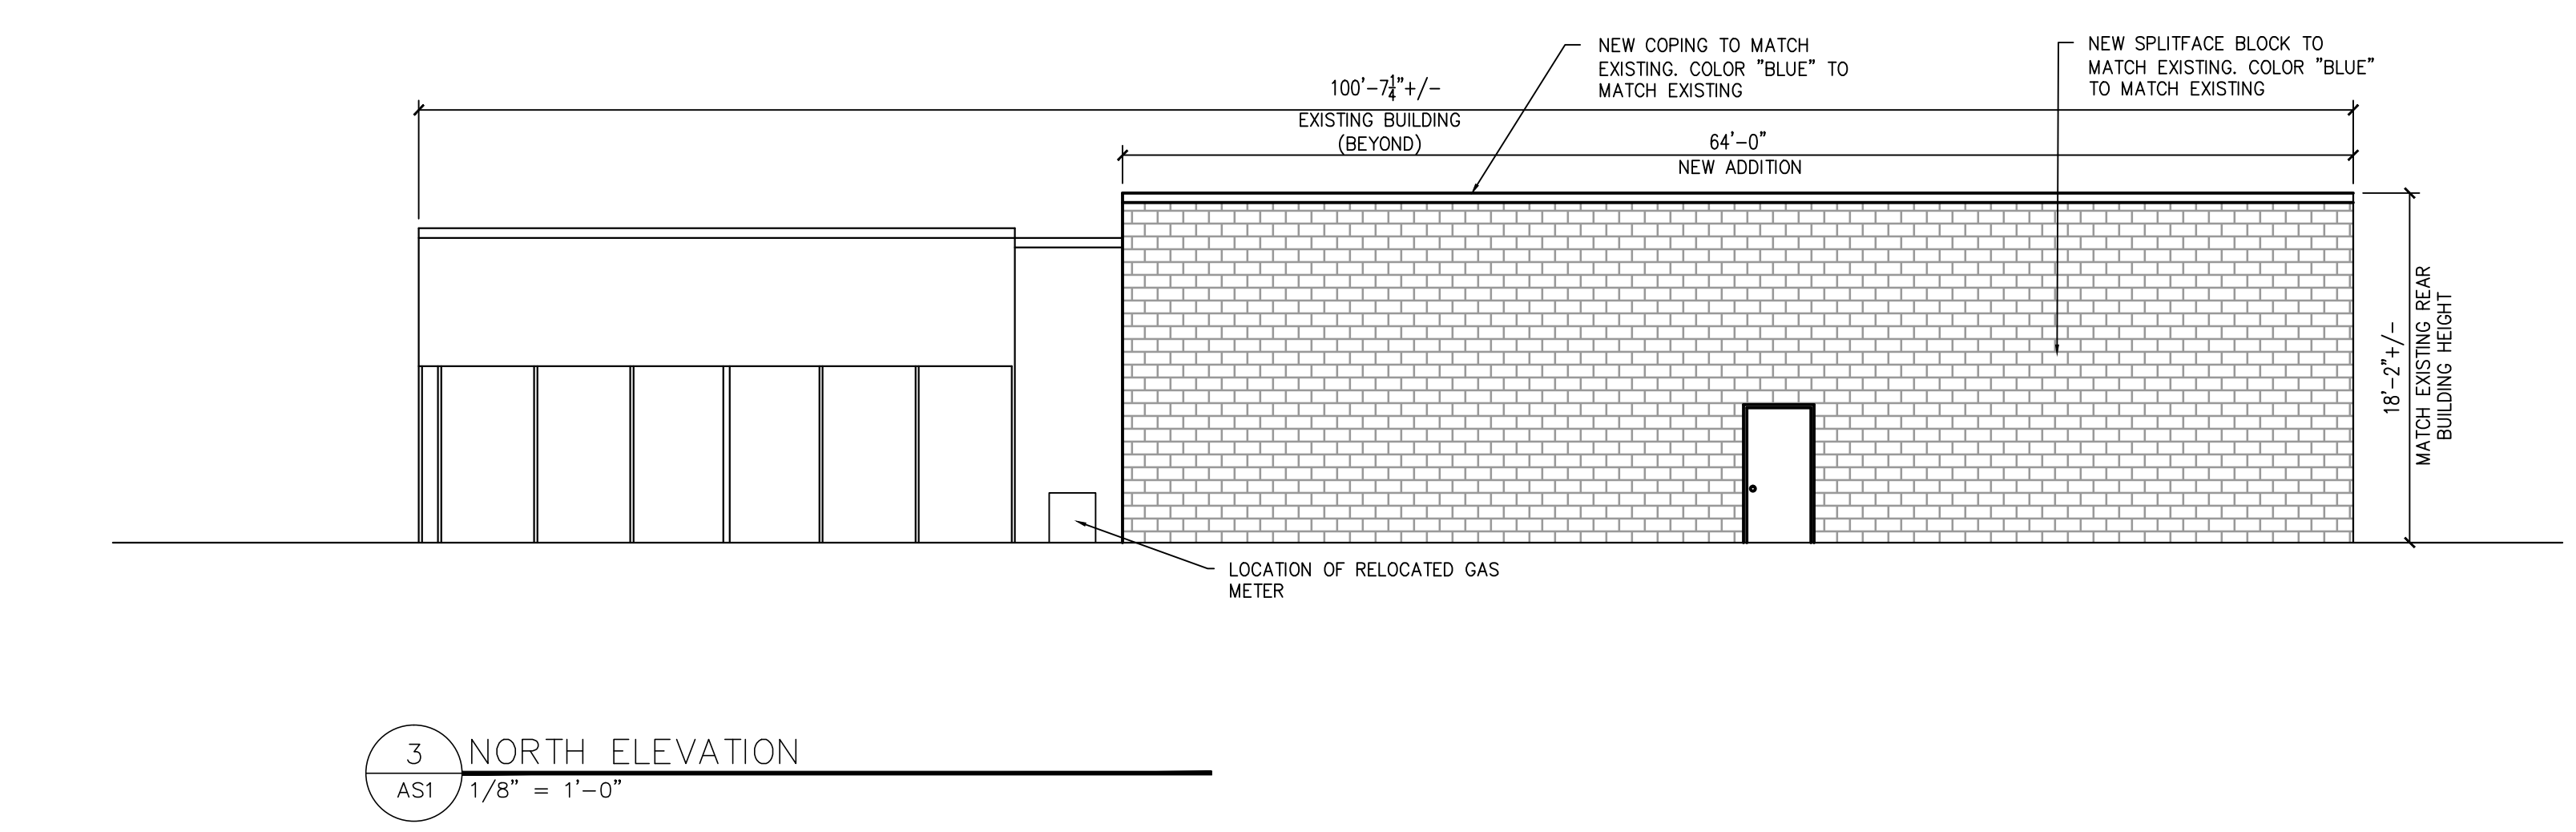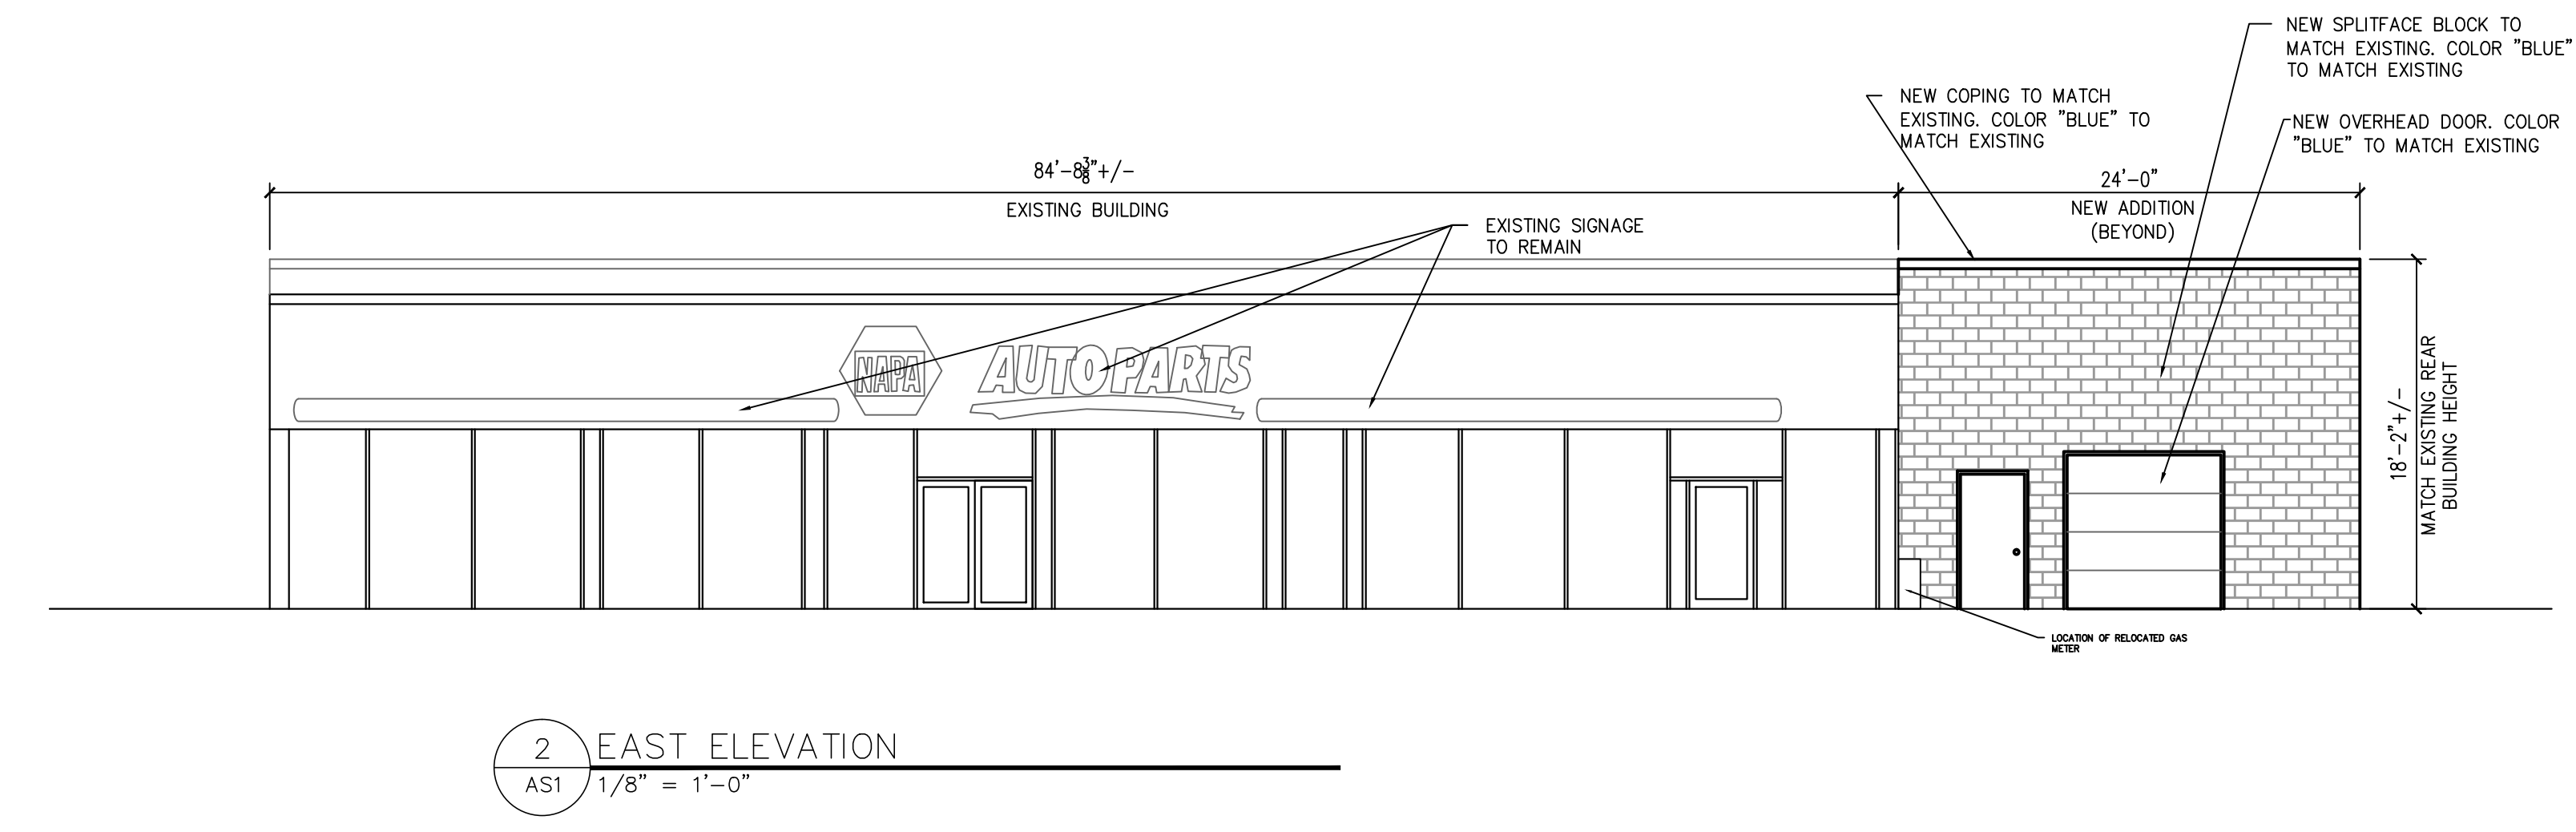

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Drawing Revisions:

No.	DATE	BY	REMARKS
1	06/21/2011	JDF	revised per architect

Job # JDF-2011-024

PROJECT: **NAPA AUTO PARTS ADDITION**
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SITE PLAN AND ELEVATIONS

Drawn By: JDF	Drawing No. AS1
Date: 06/15/2011	